


BALCONY LEVEL

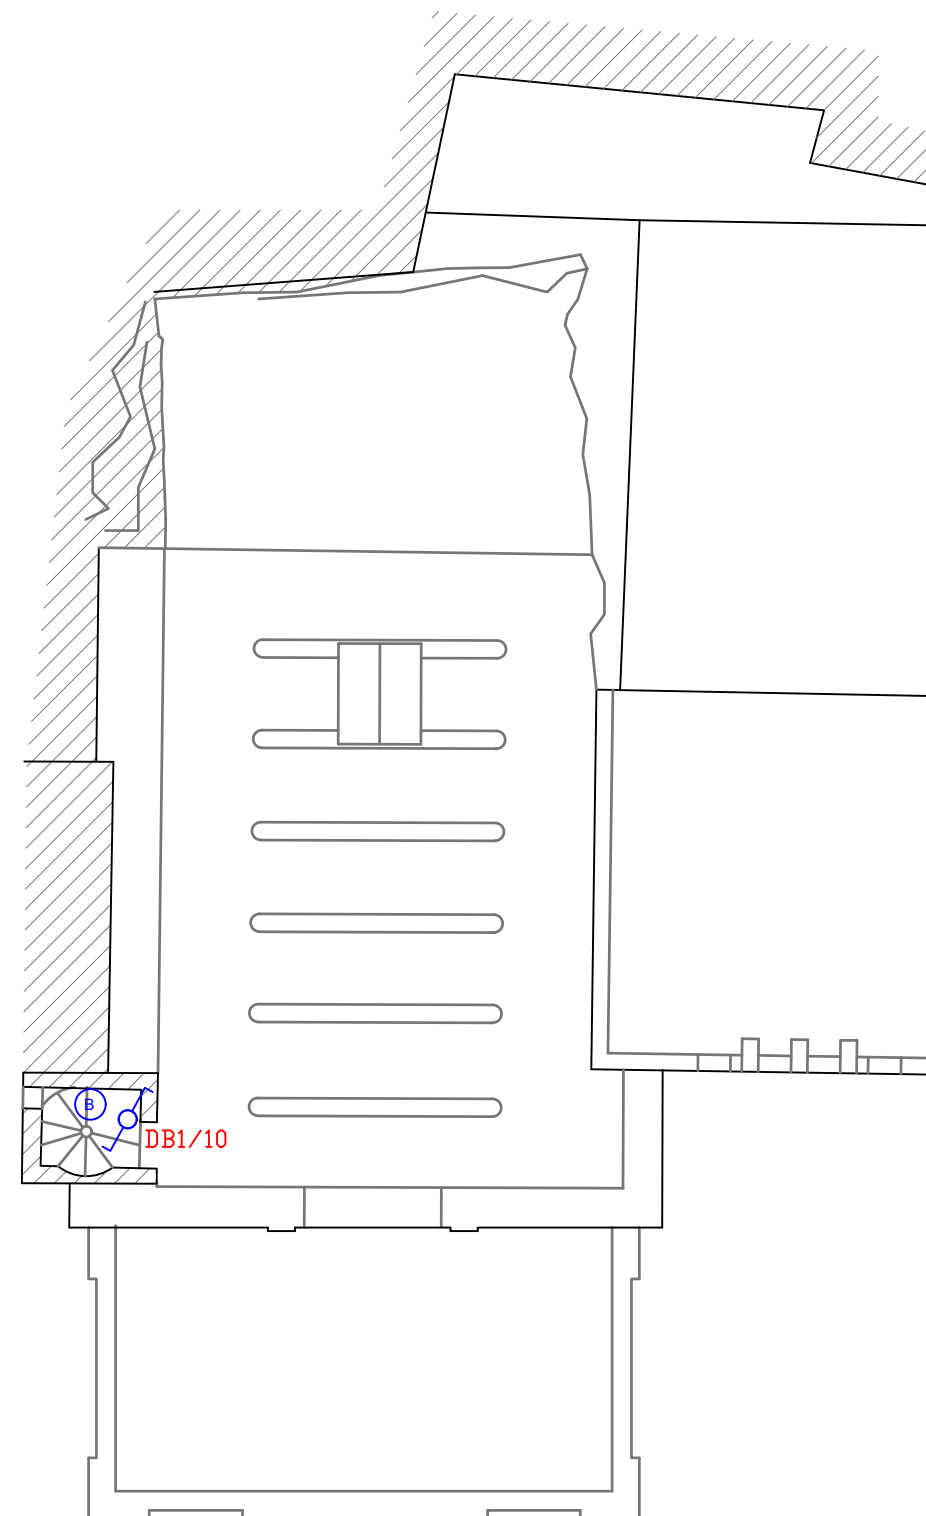

ROOF LEVEL

LEGEND

- ONE GANG ONE WAY SWITCH
- TWO GANG ONE WAY SWITCH
- THREE GANG ONE WAY SWITCH
- TWO WAY SWITCH/INTERMEDIATE
- METAL CLAD SWITCH
- CARD SWITCH
- 13A DP FUSED SWITCH
- PIR SWITCH
- CEILING MOUNTED LIGHT FITTING
- WALL MOUNTED LIGHT FITTING
- LIGHT FITTING TYPE F
- LED TUBE LIGHT
- EMERGENCY LIGHT FITTING
- FLEX OUTLET
- 2 POLE CONTACTOR AND TIMER
- ELECTROCUTTER
- IP 65 LIGHT FITTING

DB1/L1/7-1DB/PHASE No/CIRCUIT No/SWITCH

NOTES

EXISTING LIGHT FITTINGS TO BE RETAINED UNLESS OTHERWISE STATED

CANNALISATION ROUTING TO BE COORDINATED WITH ARCHITECT/ENGINEER

REV	DESCRIPTION	DATE

Ing. Edwin Aquilina

B. Mech. Eng. (Hons.) Eur Ing
Engineering Consultancy Services
Project Management
Fire Safety Engineering
Mob (+356) 99435668
E-Mail edwinaquilina@gmail.com

Drawing Title: LIGHTING PLAN BALCONY & ROOF, IMMACULATE CONCEPTION CHAPEL TRIQ IL-KUNCIZZJONI, MSIDA			
Drawing No: LE-12-021-22		Scale: 1:100 (A3)	
Project Ref: 021/22		Sheet: 1 of 1	
Drawn: IAa	Checked: EAa	Status: DESIGN	Date: 26.01.2022
DIMENSIONS IN mm			